




REISSUED: 06/17/2024

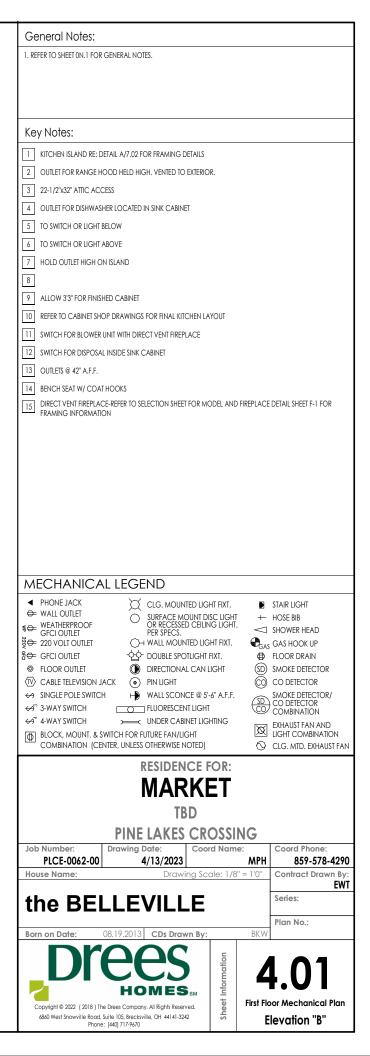

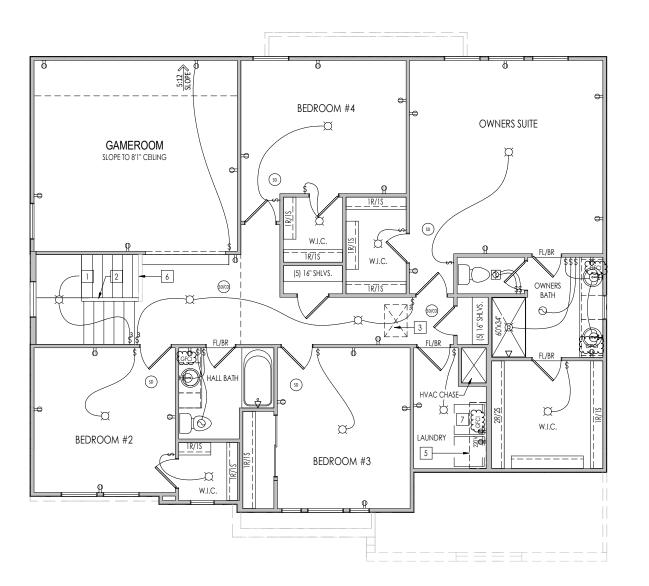

REISSUED: 06/17/2024

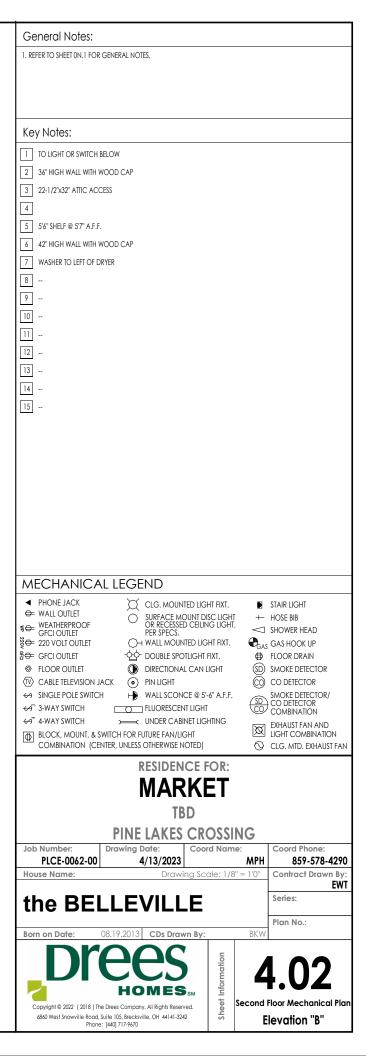


BRICK VENEER LINTEL SCHEDULE				
SPAN	STEEL ANGLE SIZE	HEIGHT OF VENEER ABOVE LINTEL		
Up to 3'-6"	L3-1/2 x3-1/2 x1/4	20 FT. MAX		
Up to 6'-0"	L5x 3-1/2x 5/16 (LLV)	20 FT. MAX		
Up to 8'-0"	L6x 3-1/2x 3/8 (LLV)	20 FT. MAX		
9'-0"	L7x 4x 3/8 (LLV)	12 FT. MAX		
*16'-0"	L7x 4x 3/8 (LLV)	3 FT. MAX		
*16'-0"	L8x 4x 1/2 (LLV)	4-1/2 FT. MAX		

ALL LINTELS <=6' SHALL HAVE 4" MINIMUM BEARING AT EACH END.

ALL LINTELS >=6' SHALL HAVE 8" MINIMUM BEARING AT EACH END.

*FASTENDED TO HDR @ 1/3 SPAN POINTS THRU 1-1/2 "LONG VERTICALLY SLOTTED HOLES IN LINTEL w/
1/2" DIA. x 3-1/2 "LONG LAG SCREWS. LOCATE LAG SCREWS @ MIDDLE OF SLOTTED HOLE & TIGHTEN
SCREWS ENOUGH TO ALLOW MOVEMENT OF LINTEL.

***ANY LINTEL CONDITION NOT SPECIFIED ABOVE SHALL BE DESIGNED

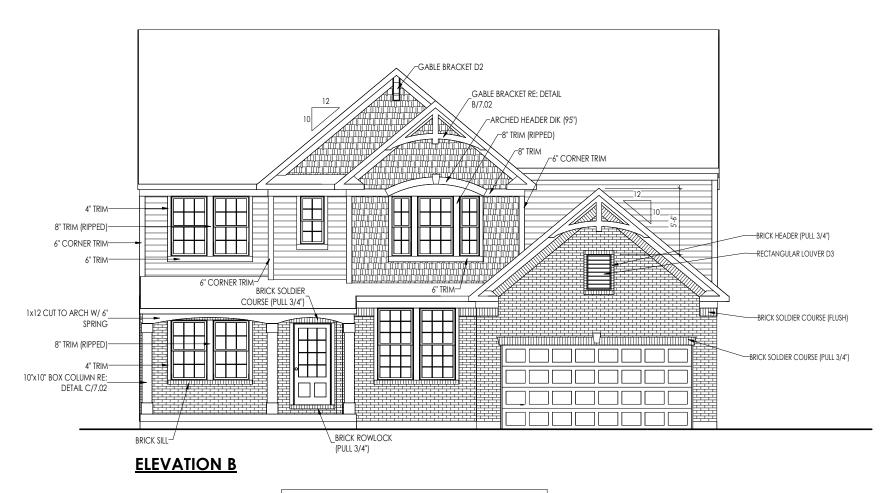

NOTE: STONE OR BRICK TO GRADE (BRICK/STONE LEDGE) - FIELD VERIFY DROPPED LOCATIONS

REISSUED: 05/09/2024

General Notes:						
REFER TO SHEET 0N.1 FOR ROOFING MATERIAL PER S						
Karrala an						
Key Notes:						
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		TBD				
	PINE L	AKES CR	OSSING			
Job Number:	Drawing Date	e: Coo	rd Name:	Coord Phone:		
PLCE-0062-00 House Name:	4/1	3/2023 Drawing Sc	MP ale: 1/8" = 1'0			
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the BEI	_LEV	ILLE		Series:		
Born on Date:	08.19.2013 C	Ds Drawn By:	BK	Plan No.:		
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Copyright © 2022 (2018) The	e Drees Company. All	Rights Reserved.	l leet I	Front Elevation		
6860 West Snowville Road, S Phone	Suite 105, Brecksville, (: [440] 717-9670	OH 44141-3242	\$	Elevation "B"		